

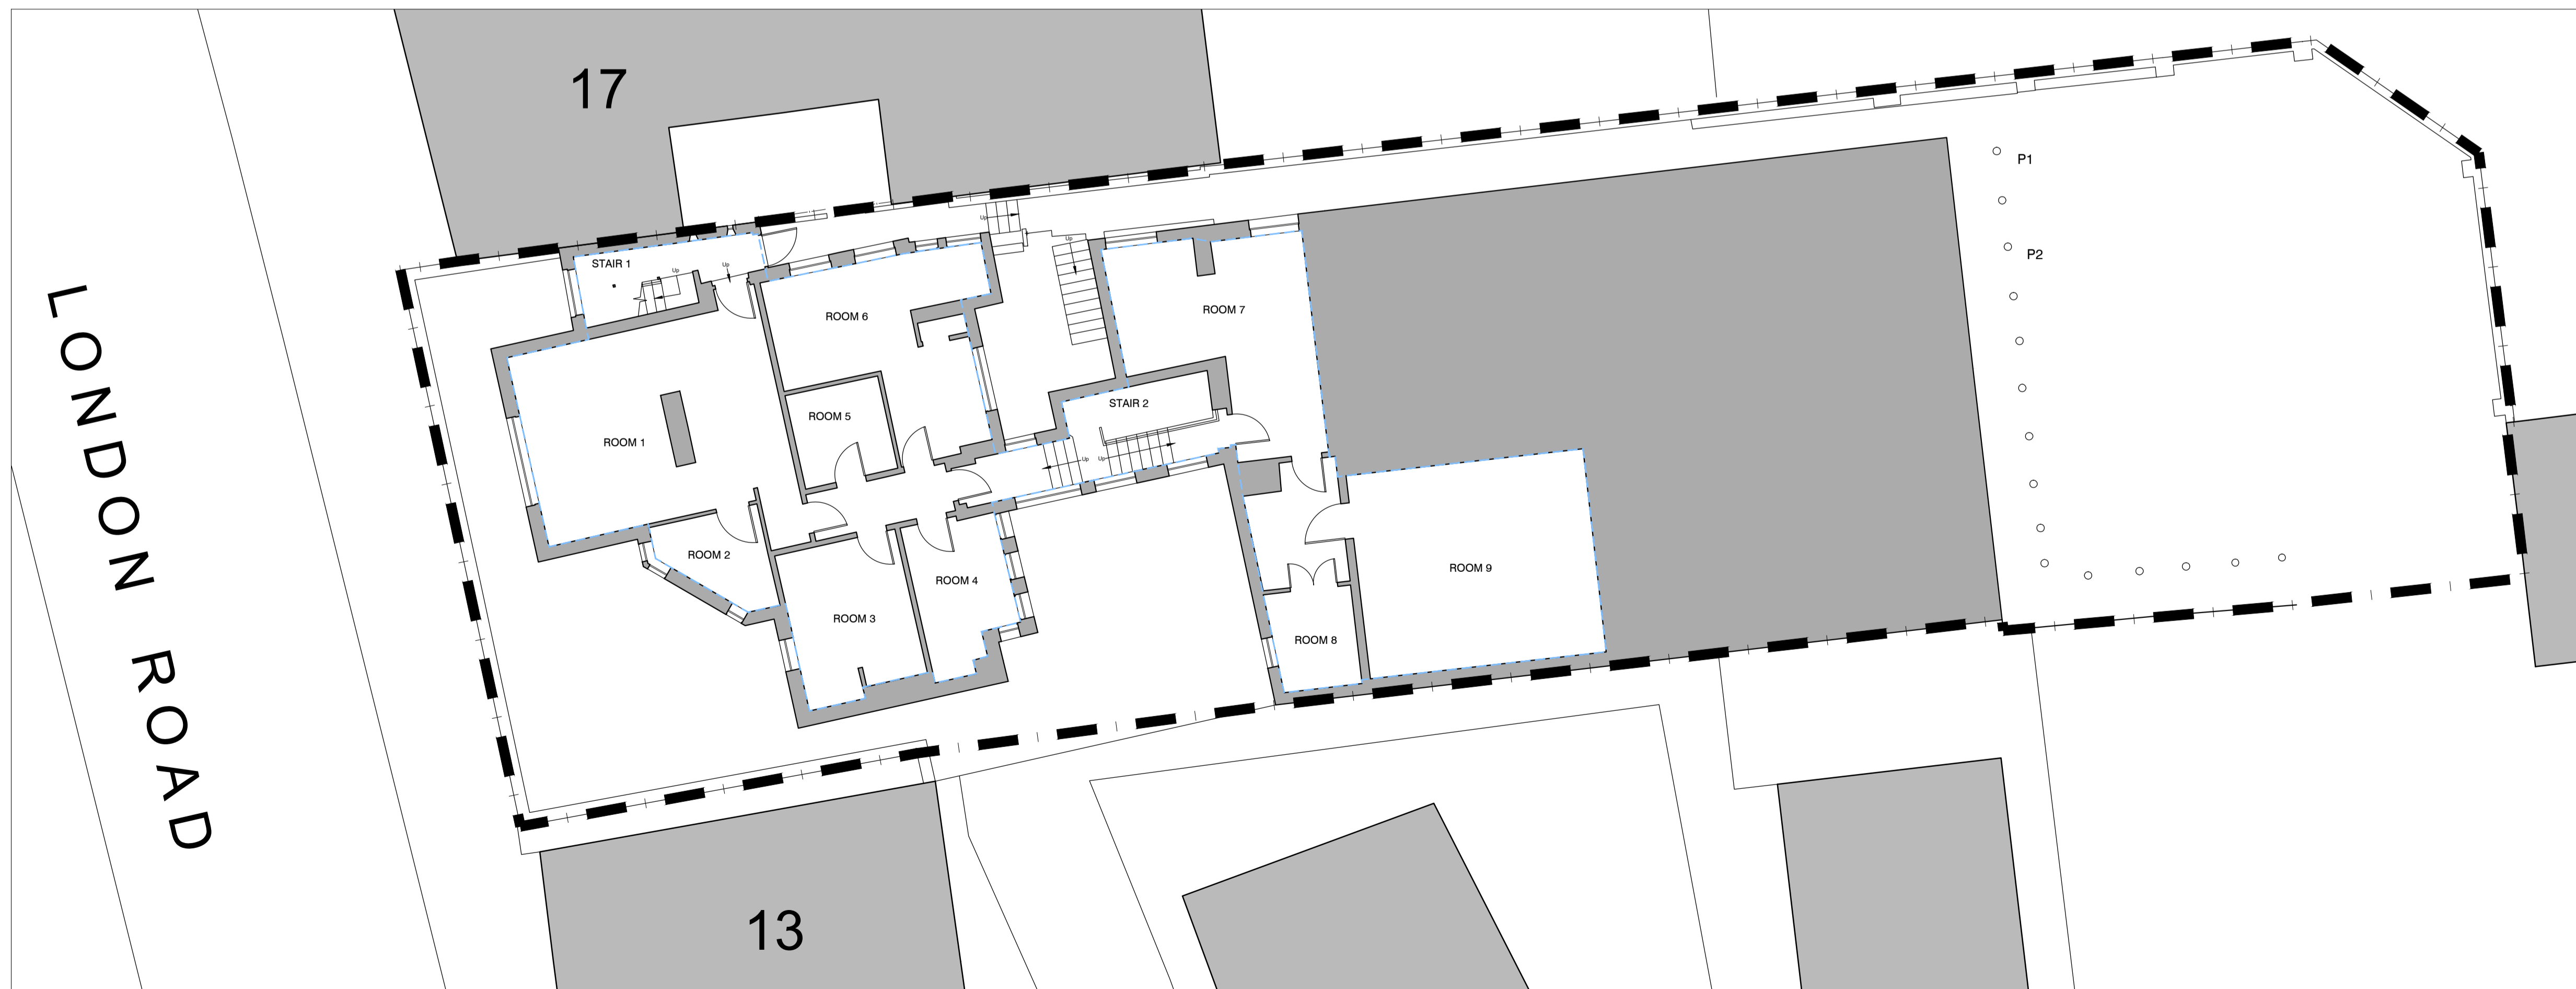


EXISTING SECOND FLOOR PLAN - G.I.A - 49m² = 527ft²

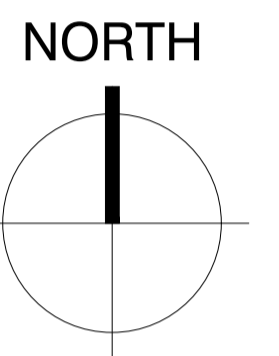

EXISTING FIRST FLOOR PLAN - G.I.A - 183m² = 1970ft²

DISCLAIMER NOTE:
 ADJACENT PROPERTIES AND BOUNDARIES ARE SHOWN FOR ILLUSTRATIVE PURPOSES ONLY AND HAVE NOT BEEN SURVEYED UNLESS OTHERWISE STATED.
 ALL AREAS SHOWN ARE APPROXIMATE AND SHOULD BE VERIFIED BEFORE FORMING THE BASIS OF A DECISION.
 DO NOT SCALE OTHER THAN FOR PLANNING APPLICATION PURPOSES.
 ALL DIMENSIONS MUST BE CHECKED BY THE CONTRACTOR BEFORE COMMENCING WORK ON SITE.
 NO DEVIATION FROM DRAWING WILL BE PERMITTED WITHOUT THE PRIOR WRITTEN CONSENT OF ASCOT DESIGN.
 THE COPYRIGHT OF THIS DRAWING REMAINS WITH ASCOT DESIGN AND MAY NOT BE REPRODUCED IN ANY FORM WITHOUT WRITTEN CONSENT.
 GROUND FLOOR SLAB, FOUNDATIONS, SUB-STRUCTURES, ETC. ALL WORK BELOW GROUND LEVEL IS SHOWN PROVISIONALLY. INSPECTION OF GROUND CONDITIONS IS ESSENTIAL PRIOR TO WORK COMMENCING.
 REASSESSMENT IS ESSENTIAL WHEN THE GROUND CONDITIONS ARE APPARENT AND REDESIGN MAY BE NECESSARY IN THE LIGHT OF SOIL CONDITIONS FOUND. THE RESPONSIBILITY FOR ESTABLISHING THE SOIL AND SUB-SOIL CONDITIONS RESTS WITH THE CONTRACTOR.

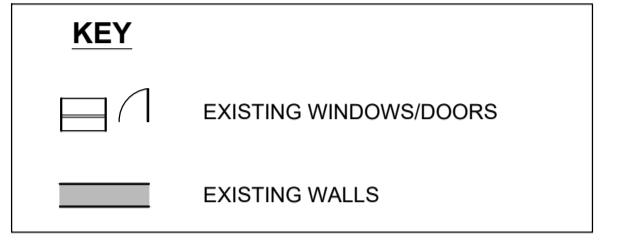

SITE AREA = 0.071 Ha

**EXISTING BUILDING
 TOTAL G.I.A - 232m² = 2494ft²**

Rev	Date	Detail	Drwn	Chk

0 2m 4m 6m 8m 10m
 0 100mm
 SCALE 1:100

Status **PLANNING**

ASCOT DESIGN
 Timeless architecture

HEAD OFFICE: Ashurst Manor, Ashurst Park, Church Lane, Sunninghill, Ascot, SL5 7DD. Tel: 01344 299 330

MANCHESTER: No. 1 Booths Park, Chelford Road, Knutsford, WA16 8GS. Tel: 01565 756 147

LONDON: 29 Farm Street, Mayfair, London, W1J 5RL. Tel: 020 39940015

Email: info@ascotdesign.com
 www.ascotdesign.com

Client **EMH ELECTRICAL AND BUILDING SERVICES**

Project Title **15 LONDON ROAD, EAST GRINSTEAD, RH19 1AJ**

Drawing Title **EXISTING SITE PLAN FIRST & SECOND FLOOR PLAN**

Scale	Date	Drawn	Rev
1:100 @ A1	FEB '26	D.Q	

Drawing N° **25 - J4875 - 04 - 002**

The Copyright in this document and design is confidential to and the property of Ascot Design Limited.